
## SITE PLAN 1:1000 @ A1

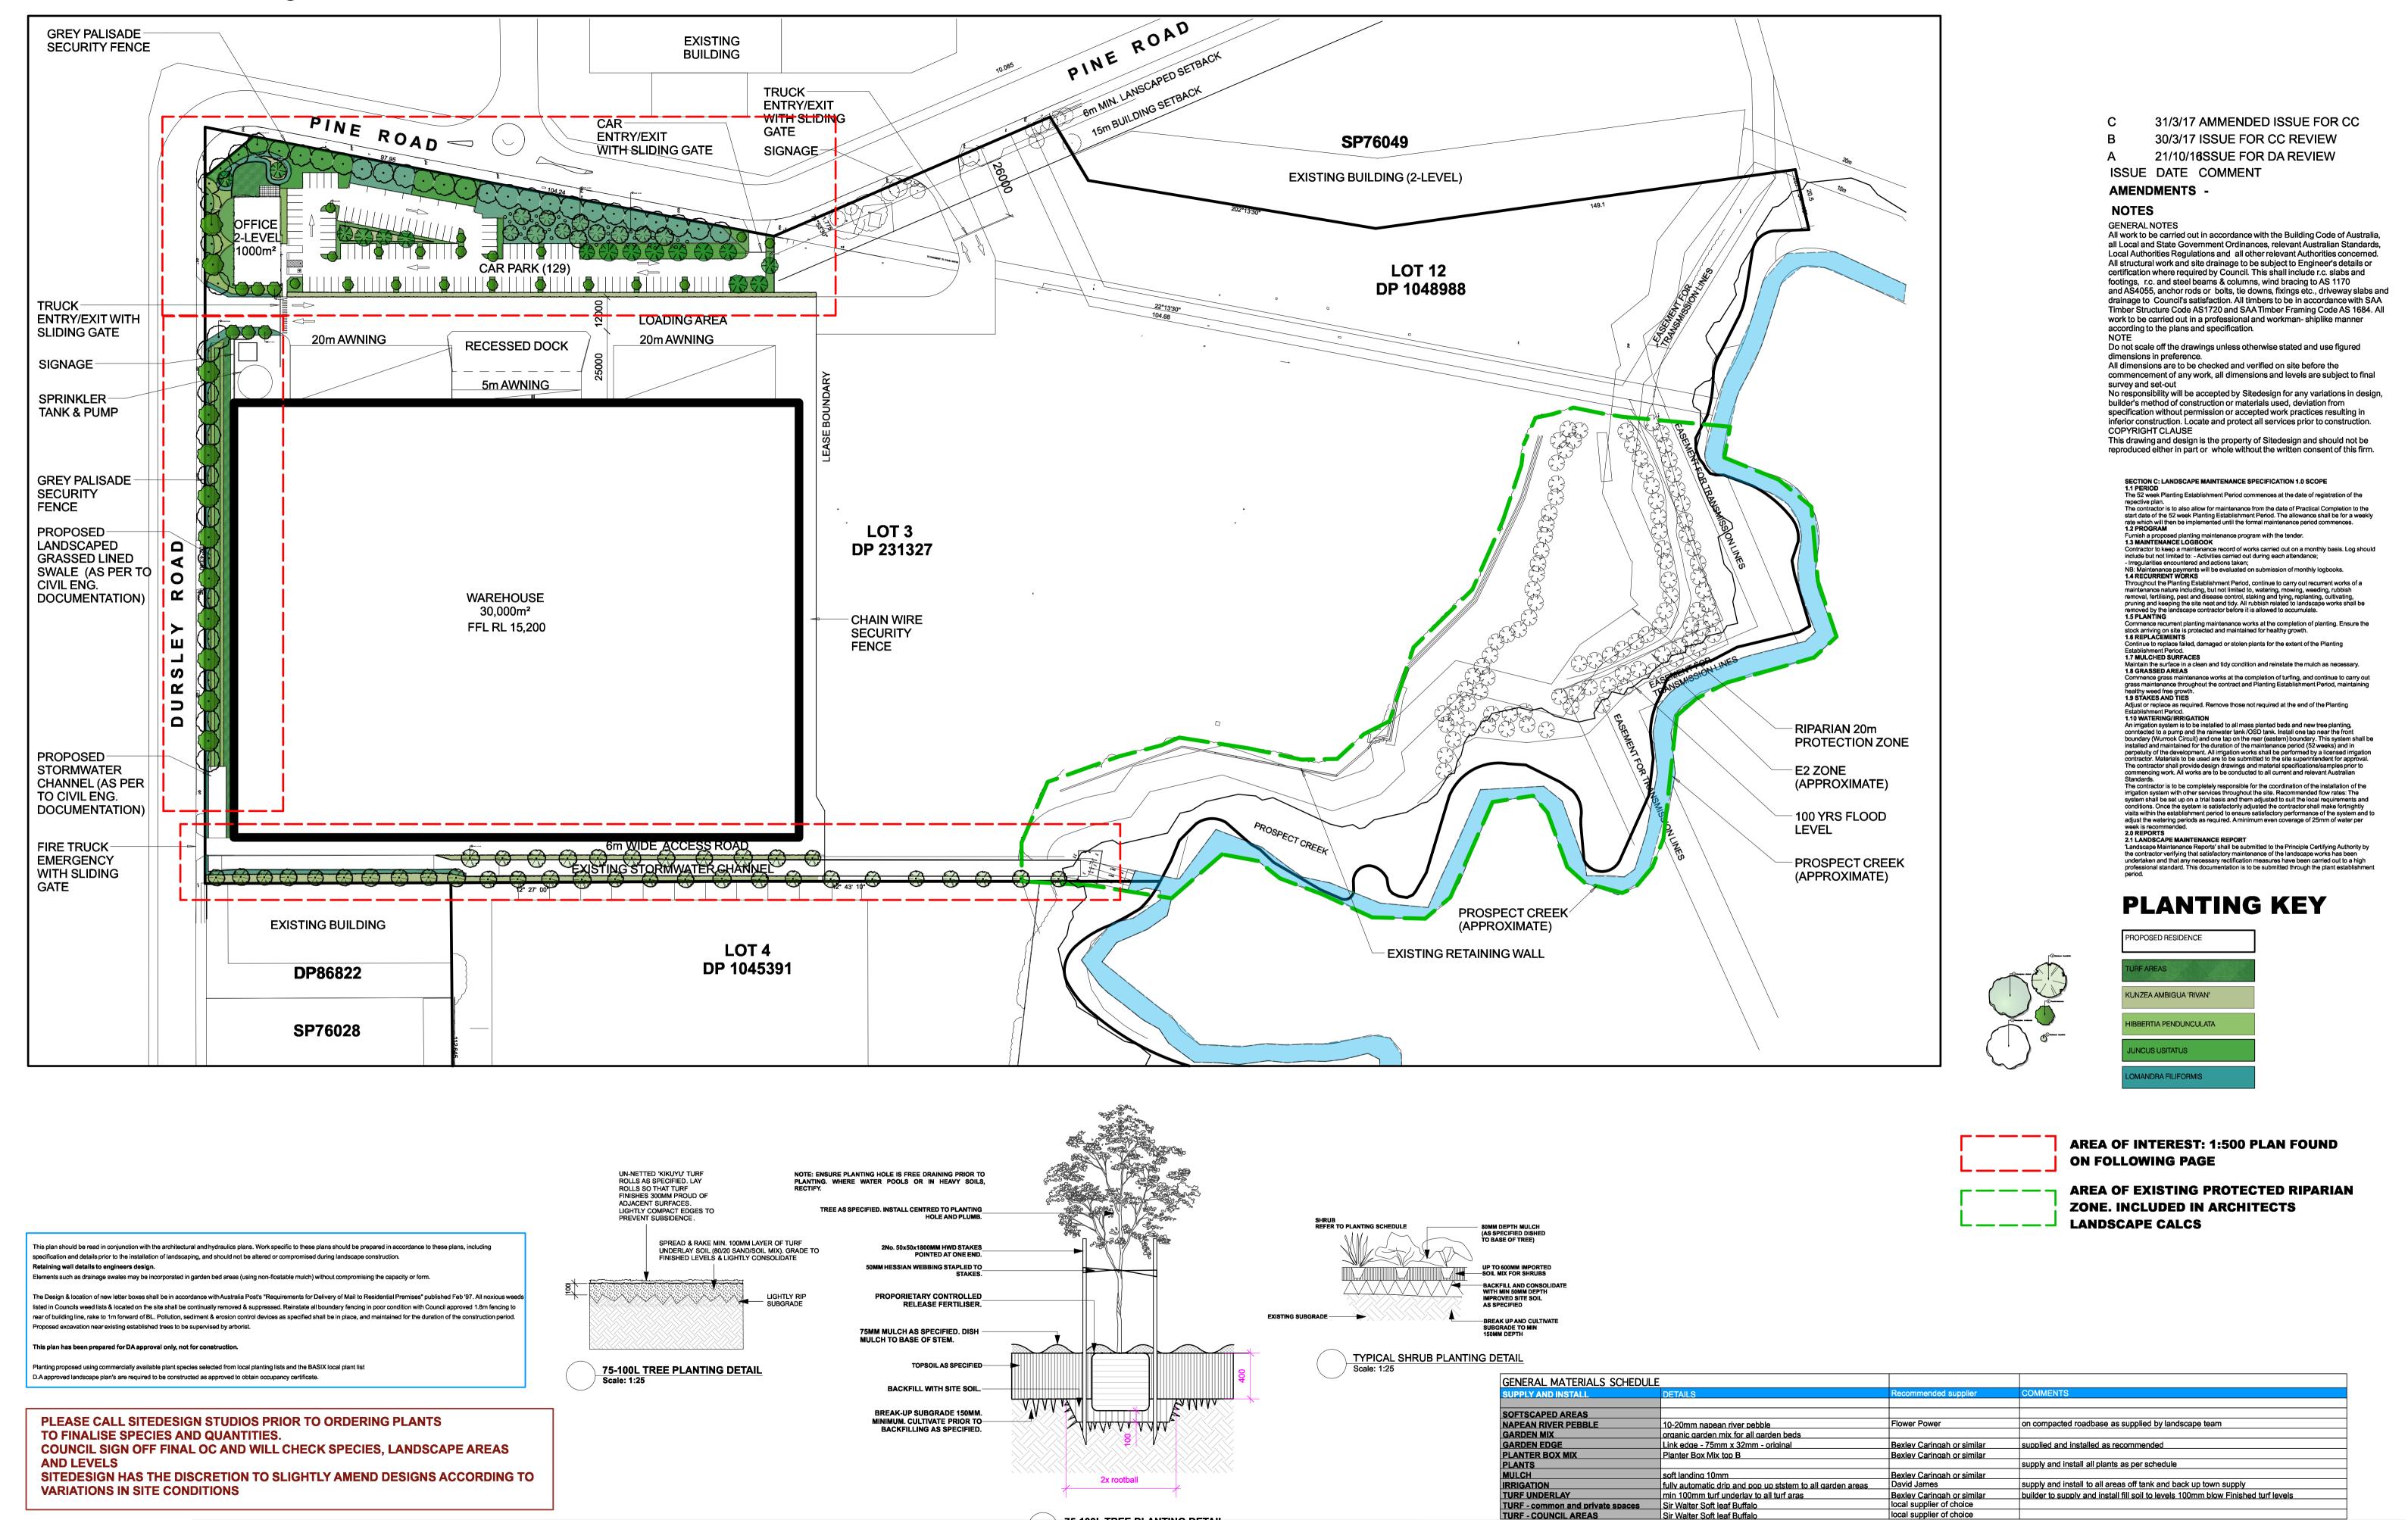

creating places to live in and enjoy

SITEDESIGN +STUDIOS

PO BOX 978
CRONULLA 2230
p 1300 22 44 55
info@sdstudios.com.au
www.sdstudios.com.au

Project PROPOSED DEVELOPMENT

Address LOTS 3, 7 AND 12, YENNORA

Client


Drawing Title LANDSCAPE PLANS

FIFE GROUP Scale 1:100 Drawing No. 1551

Page

L-01

# **DURSLEY ROAD LANDSCAPE** PLAN 1:500 @ A1

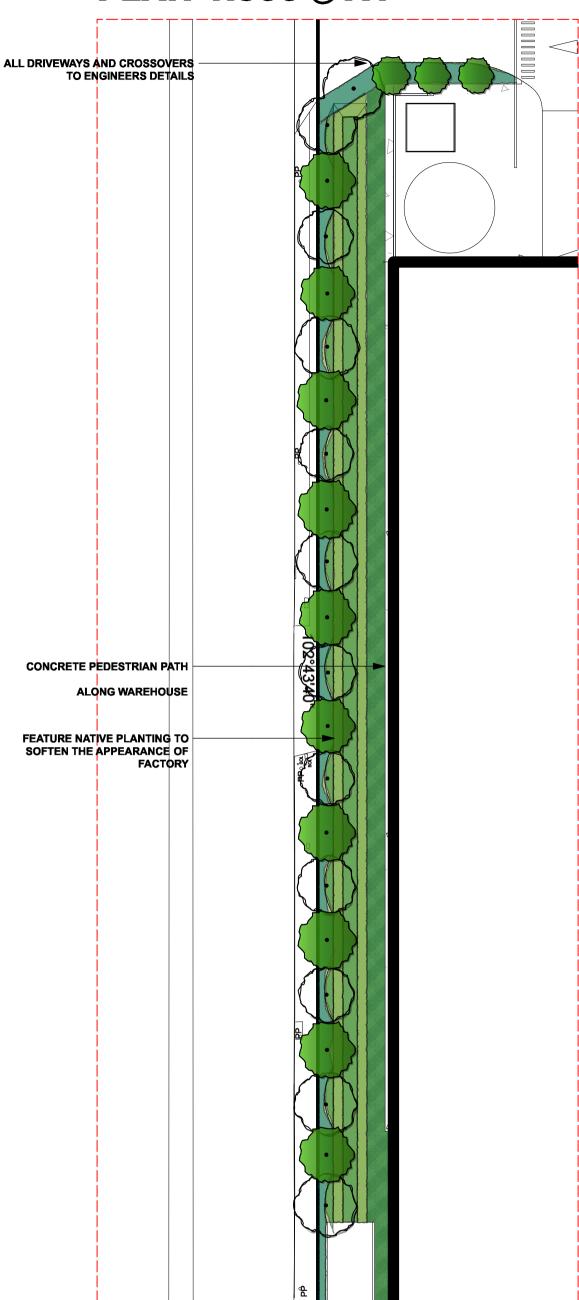

### PINE ROAD LANDSCAPE PLAN 1:500 @ A1



31/3/17 AMMENDED ISSUE FOR CC

30/3/17 ISSUE FOR CC REVIEW 21/10/16SSUE FOR DA REVIEW

ISSUE DATE COMMENT


#### **AMENDMENTS -**

All work to be carried out in accordance with the Building Code of Australia all Local and State Government Ordinances, relevant Australian Standards Local Authorities Regulations and all other relevant Authorities concerned All structural work and site drainage to be subject to Engineer's details or certification where required by Council. This shall include r.c. slabs and footings, r.c. and steel beams & columns, wind bracing to AS 1170 and AS4055, anchor rods or bolts, tie downs, fixings etc., driveway slabs and drainage to Council's satisfaction. All timbers to be in accordance with SAA Timber Structure Code AS1720 and SAA Timber Framing Code AS 1684. All work to be carried out in a professional and workman-shiplike manner according to the plans and specification.

Do not scale off the drawings unless otherwise stated and use figured dimensions in preference. All dimensions are to be checked and verified on site before the commencement of any work, all dimensions and levels are subject to fina survey and set-out

No responsibility will be accepted by Sitedesign for any variations in design, builder's method of construction or materials used, deviation from specification without permission or accepted work practices resulting in inferior construction. Locate and protect all services prior to construction. This drawing and design is the property of Sitedesign and should not be reproduced either in part or whole without the written consent of this firm.

# ACCESS ROAD LANDSCAPE PLAN 1:500 @ A1

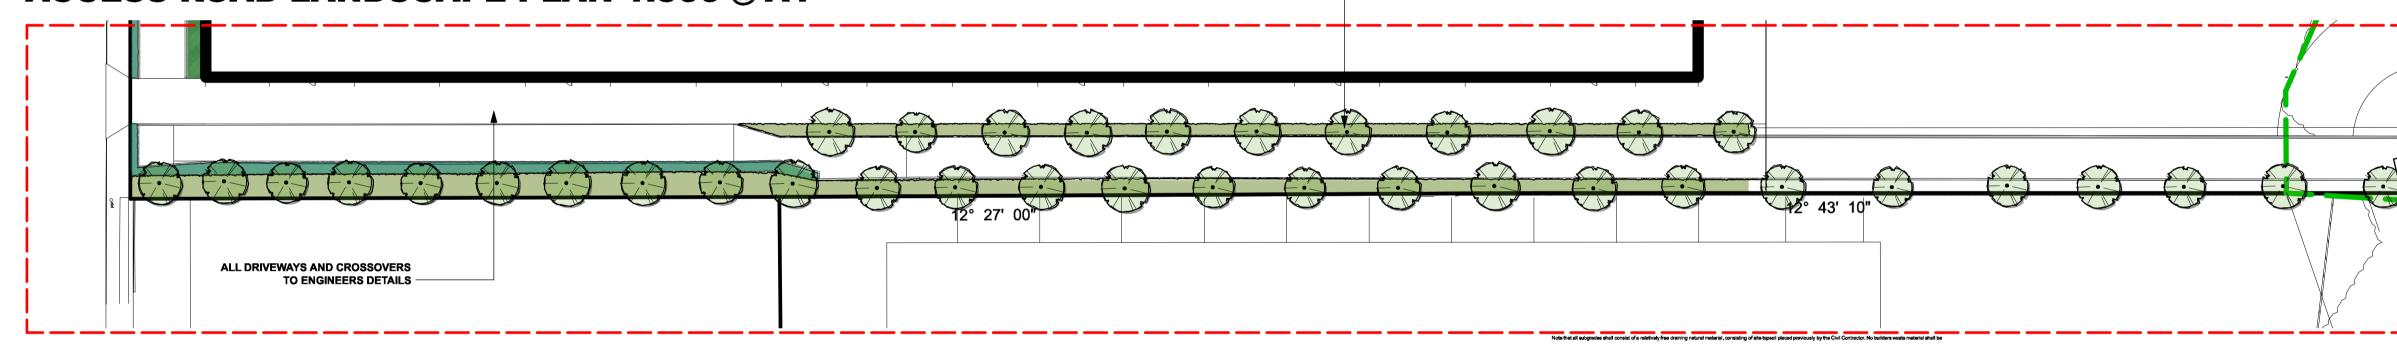

- Sediment fencing using a geotextile filter fabric in the location indicated on the erosion control plan or as instructed on

Turf areas - 100mm below finished surface level.

Client

PRELIMINARIES 1.01 GENERAL

**AVENUE OF INDIGENOUS CANOPY** 

TREES ALONG ACCESS WAY TO

REINSTATE HABITAT AND LINK TO

ID	Qty	Common Name	Botanical Name	Scheduled Size	Mature Height	Mature Spread
Trees						
Ac-dec	38	black wattle	Acacia decurrens	45L	3-10m	2.0 - 4m
Cas-gla	16	Grey (Swamp) She-oak	Casuarina glauca	45L	10 - 15m	3.5 - 6m
EU P	1	Blackbutt	Eucalyptus pilularis	75L	over 30m	6 - 10m
EUT	44	Forest Red Gum, Burringoa	Eucalyptus tereticornis	45L	over 30m	6 - 10m
ML	50	Flax-leaved Paperbark	Melaleuca lineariifolia	45L	5 - 10m	6 - 10m
Shrubs						
kun-amb'r'	1136	Tick Bush	Kunzea ambigua 'Rivan'	150mm	1.5 - 3m	1.2 - 2.0m
mel-thy	33	Thyme Honeymyrtle	Melaleuca thymifolia	200mm	1m	1m
Ground Covers			-			
hib-ser	3048	Guinea Flower	Hibbertia pendunculata	300mm	0.0 - 0.3m	0.0 - 0.3m
Grasses						
jun-us	6420	tussock grass	Juncus usitatus	150mm	1m	0.8m
lom-fi	5633	SAVANNA BLUE(tm)	Lomandra filiformis	150mm	0.6m	0.8m
Climbers						
Aquatic Plants						
Perennials						

The following general conditions should be considered prior to the commencement of landscape works: The landscape plans should be read in conjunction with the architectural plans, hydraulic plans, service plans an

Place the specified soil conditioner to the required compacted depth and use a rotary hoe to thoroughly

All planting set out shall be in strict accordance with the drawings, or as directed. Note that proposed tree planting located near services should be adjusted at this stage. Notify Landscap and the outer roots gently tessed from the soil mass. Immediately set plant in hole and backfill with specified soil mix, incorporating the approved quantity of fertiliser for each plant type.

schedule shall be staked with a min. 3 stakes. Mulch should be spread so that a compacted thickness of 75mm is achieved after settlement in all planting beds and around each individual plant. Apply immediately following planting and

moist until roots have taken and sods/rolls cannot be lifted. Keep all traffic off turf until this has occurred. Allow for top dressing of all turf areas. All turf shall be rolled immediately following

The Landscape Contractor shall be engaged with the Irrigation Specialist to co-ordinate with the Project Manager to identify the preferred service and conduit locations.

Removing weeds, pruning and general plant maintenance.


Topping up of mulched areas.


Fertilizing with approved fertilizers at correct rates.

Maintenance of all paving, retaining and hardscape elements.

# **PLANTING KEY AND DETAILS**



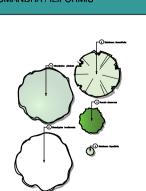

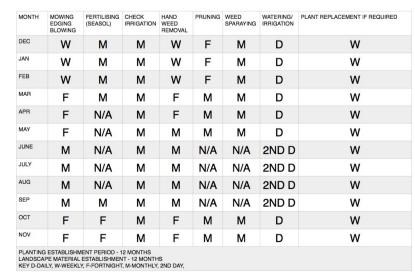

SITEDESIGN +STUDIOS

SOUTH SYDNEY STUDIO PO BOX 978 **CRONULLA 2230** p 1300 22 44 55 info@sdstudios.com.au www.sdstudios.com.au

PROPOSED DEVELOPMENT

LOTS 3, 7 AND 12, YENNORA

Drawing Title LANDSCAPE PLANS

Scale FIFE GROUP

creating places to live in and enjoy

PLANT SCHEDULE

Drawing No. **1551**